
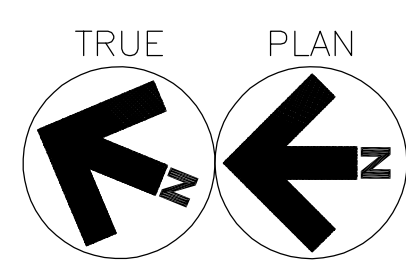


ONE EIGHTH INCH = ONE FOOT
ONE QUARTER INCH = ONE FOOT
ONE HALF INCH = ONE FOOT
ONE INCH = ONE FOOT
ONE AND ONE HALF INCHES = ONE FOOT
THREE INCHES = ONE FOOT

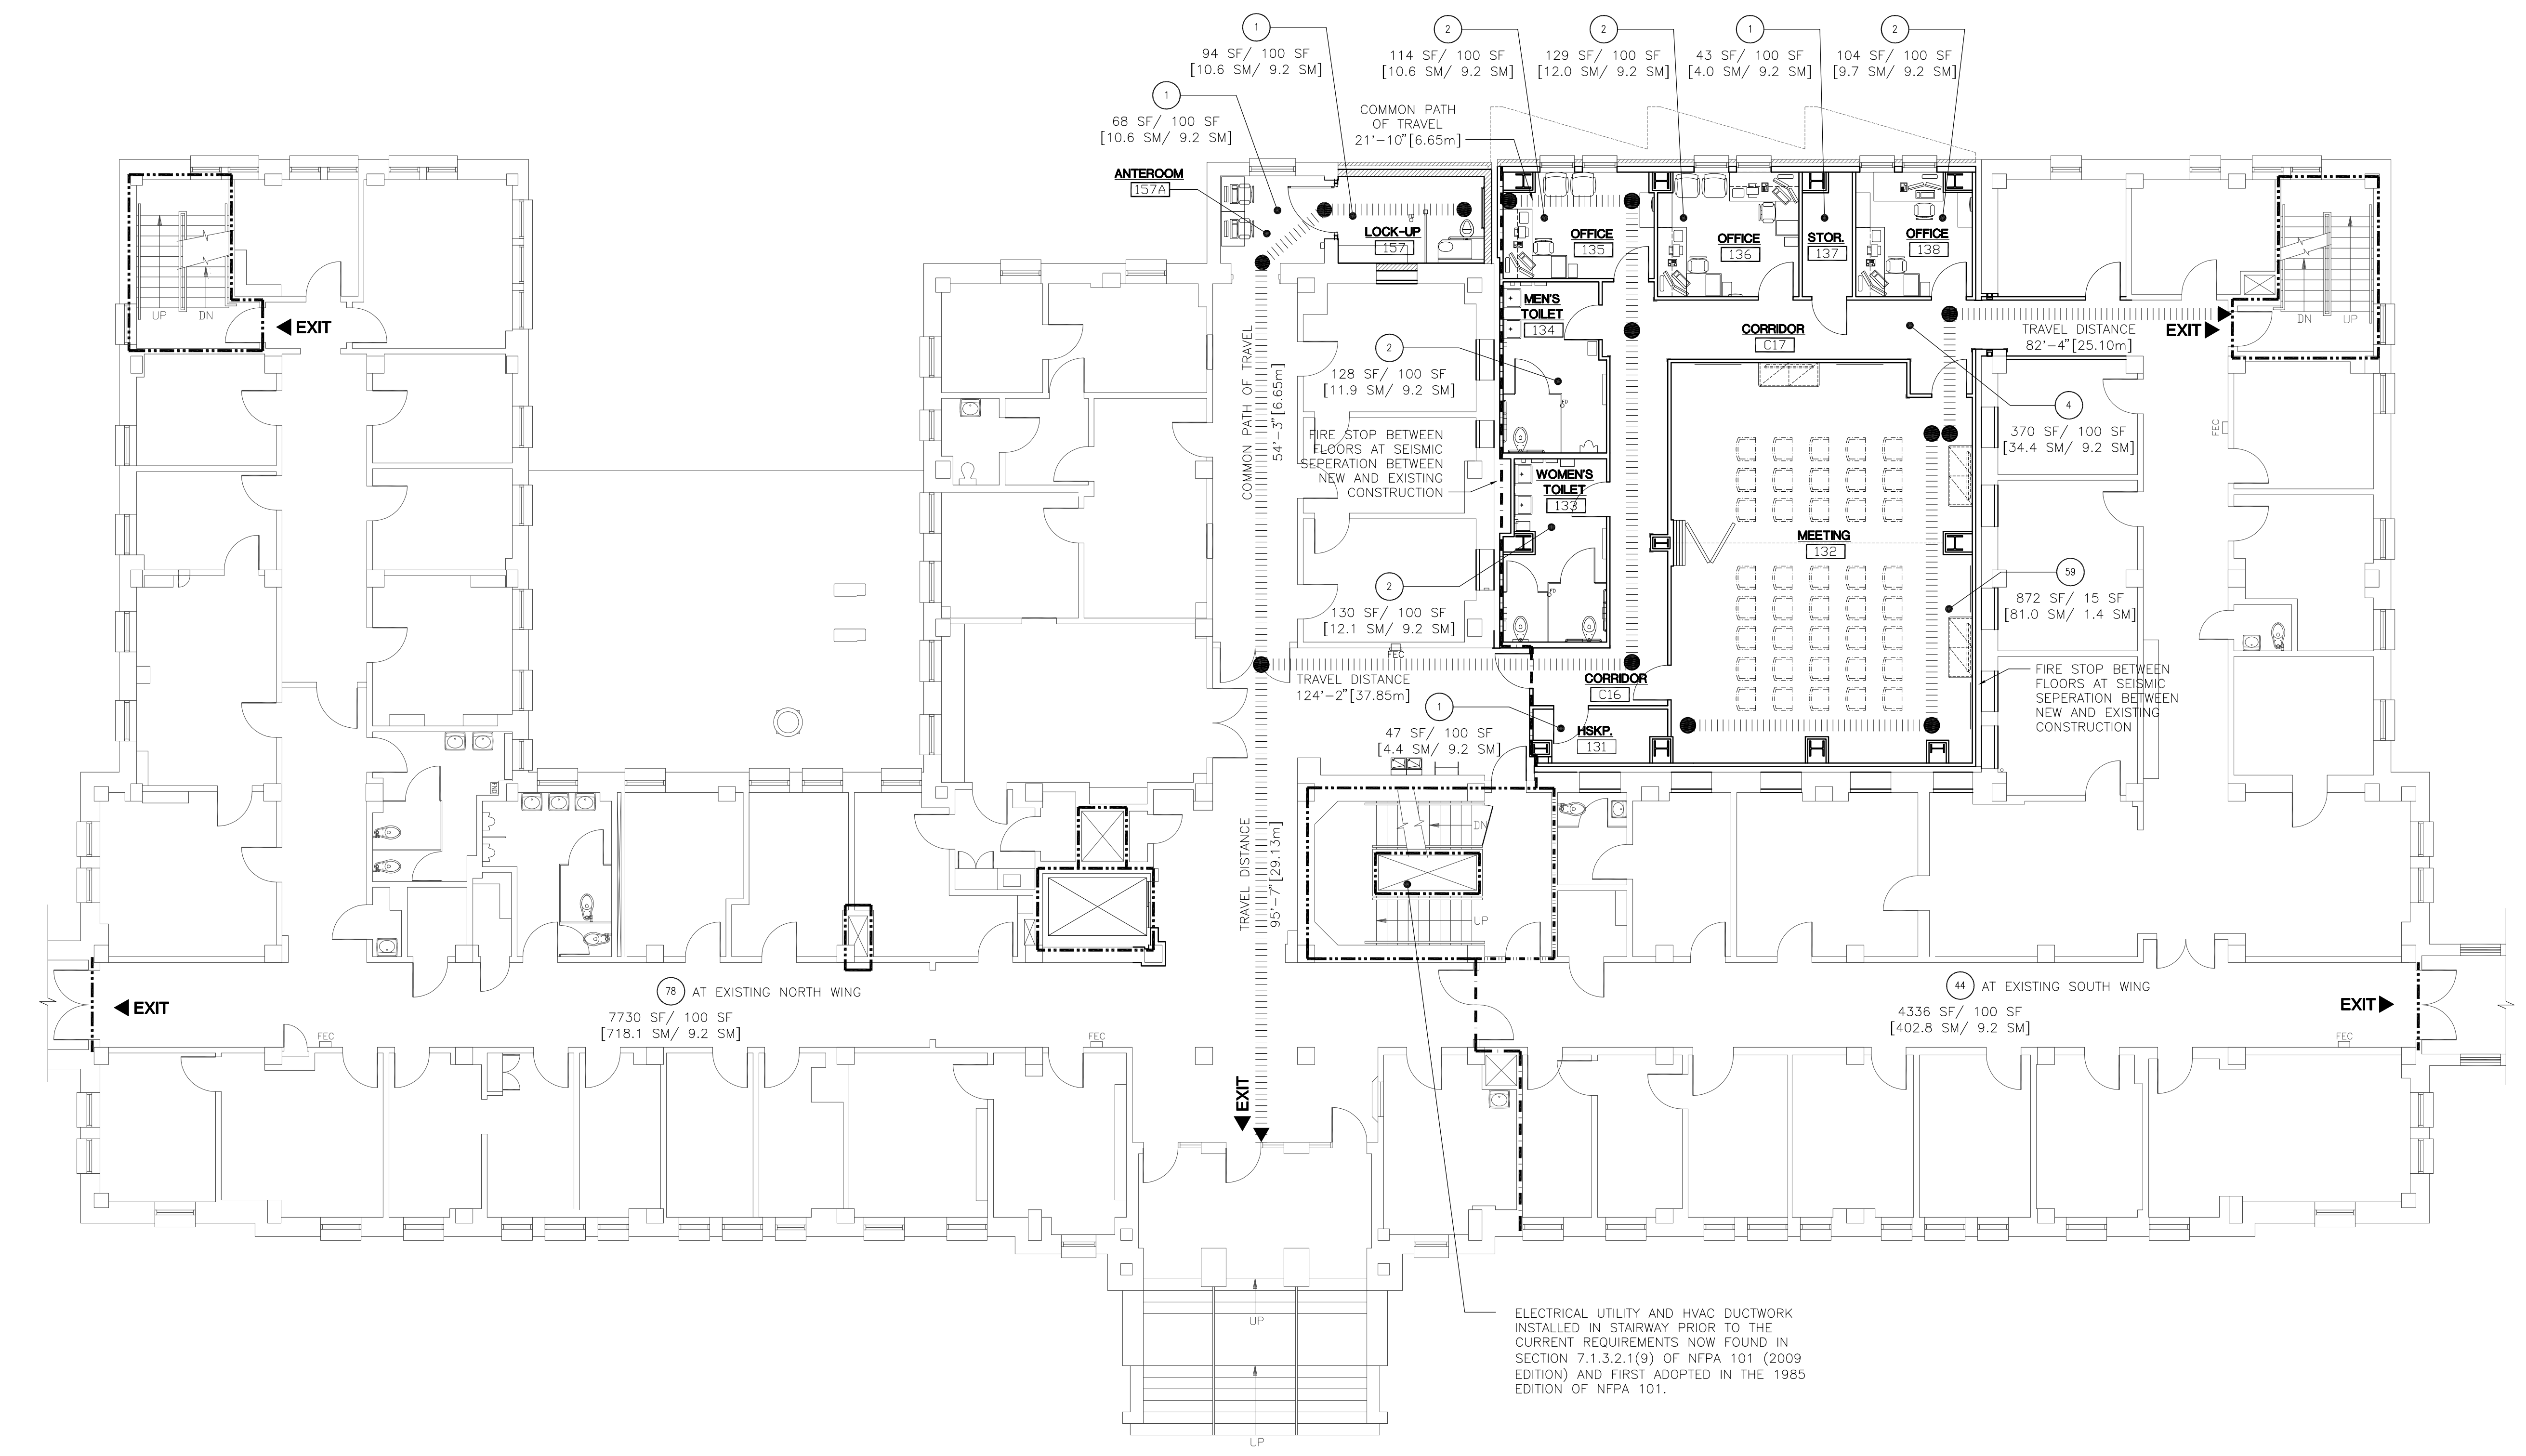

1 FIRST FLOOR LIFE SAFETY PLAN

SCALE: 1/8" = 1'-0"

AREA CALCULATIONS

FIRST FLOOR ADDITION NET AREA: 2,207 SQUARE FEET
FIRST FLOOR NET AREA: 14,003 SQUARE FEET
FIRST FLOOR GROSS AREA: 16,389 SQUARE FEET

APPLICABLE STANDARDS AND CODES

VA DIRECTIVES, DESIGN MANUALS, MASTER SPECIFICATIONS, VA BOISE MEDICAL CAD STANDARD APPLICATION GUIDE, AND OTHER GUIDANCE ON THE TECHNICAL INFORMATION LIBRARY (TIL)
INTERNATIONAL BUILDING CODE (IBC) 2009 EDITION (SEE CODE DATA AND NOTES)
NFPA 101 LIFE SAFETY CODE (LSC) 2012 EDITION (SEE CODE DATA AND NOTES)
NFPA NATIONAL FIRE CODES (SEE CODE DATA)
OCCUPATIONAL SAFETY AND HEALTH ADMINISTRATION (OSHA) STANDARDS
VA SEISMIC DESIGN REQUIREMENTS, H-18-8
NATIONAL ELECTRIC CODE (NEC)
NATIONAL STANDARD PLUMBING CODE (NSPC)
ASME BOILER AND PRESSURE VESSEL CODE
ASME CODE FOR PRESSURE PIPING
UNIFORM FEDERAL ACCESSIBILITY STANDARDS (UFAS) INCLUDING VA SUPPLEMENT, BARRIER FREE DESIGN
BUILDING CODE REQUIREMENTS FOR REINFORCED CONCRETE, AMERICAN CONCRETE INSTITUTE AND COMMENTARY
MANUAL OF STEEL CONSTRUCTION, LOAD AND RESISTANCE FACTOR DESIGN SPECIFICATIONS FOR STRUCTURAL
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ENERGY POLICY ACT OF 2005 (EPACT)
DOE INTERIM FINAL RULE: ENERGY CONSERVATION STANDARDS FOR NEW FEDERAL, COMMERCIAL AND RESIDENTIAL BUILDINGS AND NEW LOW-RISE RESIDENTIAL BUILDINGS, 10 CFR PARTS 433, 434, AND 435.
FEDERAL LEADERSHIP IN HIGH PERFORMANCE AND SUSTAINABLE BUILDINGS: 2008 MEMORANDUM OF UNDERSTANDING
EXECUTIVE ORDER 13423: STRENGTHENING FEDERAL ENVIRONMENTAL, ENERGY, AND TRANSPORTATION AND US DEPARTMENT OF VETERANS AFFAIRS: GREEN BUILDINGS ACTION PLAN
THE PROVISIONS FOR CONSTRUCTION AND SAFETY SIGNS, STATED IN THE GENERAL REQUIREMENTS SECTION
ALL VA MASTER CONSTRUCTION SPECIFICATIONS.
VENTILATION FOR ACCEPTABLE INDOOR AIR QUALITY~ ASHRAE STANDARD 62.1~ 2004.
SAFETY STANDARD FOR REFRIGERATION SYSTEMS~ ASHRAE STANDARD 15 2007.

CODE DATA:

CODES UTILIZED:
NFPA 101: LIFE SAFETY CODE, 2012 EDITION.
NFPA 220: STANDARD ON TYPES OF BUILDING CONSTRUCTION, 2012 EDITION.
FIRE PROTECTION FEATURES NOT ADDRESSED BY THE NFPA CODES SHALL COMPLY WITH THE 2009 INTERNATIONAL BUILDING CODE (IBC).
OCCUPANCY:
NEW BUSINESS OCCUPANCY, NFPA 101 CHAPTER 38.
LOCK-UP IS INCIDENTAL USE TO BUSINESS.
OCCUPANCY PER NFPA 5000 3.3.371. LOCK-UP TO MEET REQUIREMENTS OF NFPA 101 22.4.5, PER NFPA 101 38.2.11.2.
FIRST FLOOR OCCUPANT LOAD:
199 PERSONS PER NFPA 101 38.1.7 AND TABLE 7.3.1.2.
TYPE OF CONSTRUCTION:
TYPE II (222)
PER NFPA 220, TABLE 4.1.1.
FIRE RESISTIVE RATINGS:
COLUMNS SUPPORTING FLOORS - 2 HOUR
COLUMNS SUPPORTING ROOF - 1 HOUR
FLOOR BEAMS - 2 HOUR
FLOOR GIRDERS - 2 HOUR
ROOF BEAMS & TRUSSES - 1 HOUR
FLOOR & CEILING ASSEMBLIES - 2 HOUR
ROOF & CEILING ASSEMBLIES - 1 HOUR
INTERIOR NON-BEARING WALLS - NO RATING REQUIRED
EXTERIOR NON-BEARING WALLS - NO RATING REQUIRED
EXTERIOR BEARING WALLS - 2 HOUR
CONSTRUCTION OF CORRIDOR WALLS:
NO FIRE RESISTANCE RATING SHALL BE REQUIRED FOR CORRIDOR WALLS PER NFPA 101 38.3.6.1 EXCEPTION (3)
FIRE ALARM SYSTEM:
THE BUILDING SHALL RECEIVE A FIRE ALARM SYSTEM BY THE CONTRACTOR.
FIRE SPRINKLER SYSTEM:
THE BUILDING SHALL BE SPRINKLED BY THE CONTRACTOR.

GENERAL NOTES

- NFPA 101 PRIMARILY ADDRESSES LIFE SAFETY AND FIRE PROTECTION FEATURES WHILE THE IBC ADDRESSES A WIDE RANGE OF CONSIDERATIONS, INCLUDING, BUT NOT LIMITED TO, STRUCTURAL STRENGTH, SEISMIC STABILITY, SANITATION, ADEQUATE LIGHT AND VENTILATION, AND ENERGY CONSERVATION. VA BUILDINGS MUST MEET THE REQUIREMENTS OF NFPA 101 AND DOCUMENTS REFERENCED BY NFPA 101 IN ORDER TO COMPLY WITH THE ACCREDITATION REQUIREMENTS OF THE JOINT COMMISSION. THEREFORE, DESIGNS SHALL COMPLY WITH THE REQUIREMENTS OF THE LATEST EDITION OF NFPA 101 AND DOCUMENTS REFERENCED THEREIN. DESIGN FEATURES NOT ADDRESSED BY NFPA 101 OR DOCUMENTS REFERENCED THEREIN SHALL COMPLY WITH THE REQUIREMENTS OF THE LATEST EDITION OF THE IBC. FOR DESIGN FEATURES THAT ARE ADDRESSED BY BOTH THE IBC AS WELL AS NFPA 101 OR A DOCUMENT REFERENCED BY NFPA 101, THE REQUIREMENTS OF NFPA 101 OR THE DOCUMENT REFERENCED BY NFPA 101 SHALL BE USED EXCLUSIVELY (THIS APPLIES EVEN IF THE IBC REQUIREMENTS ARE DIFFERENT).
- CONFLICTS BETWEEN NATIONALLY RECOGNIZED CODES AND STANDARDS AND VA REQUIREMENTS SHOULD A CONFLICT EXIST BETWEEN VA REQUIREMENTS AND VA ADOPTED NATIONALLY RECOGNIZED CODES AND STANDARDS, THE CONFLICT SHALL BE BROUGHT TO THE ATTENTION OF VA. THE RESOLUTION OF THE CONFLICT SHALL BE MADE BY THE AUTHORITY HAVING JURISDICTION FOR VA TO ENSURE A CONSISTENCY SYSTEM WIDE.
- PENETRATIONS THROUGH RATED ASSEMBLIES SHALL BE FIRESTOPPED IN ACCORDANCE WITH NFPA STANDARDS.
- CONTRACTOR TO MAINTAIN CONTINUITY OF ALL EXISTING RATED ASSEMBLIES UNTIL SUCH TIME THAT IT MAY BE REPLACED WITH NEW CONSTRUCTION. (I.E. DOORS ON STAIR TOWERS MAY NOT BE REMOVED UNTIL NEW DOORS ARE READY TO REPLACE THEM).

LEGEND:

- INDICATES PATH OF TRAVEL
- FEC FIRE EXTINGUISHER AND CABINET
- FE BRACKET MOUNTED FIRE EXTINGUISHER
- EXIT INDICATES REQUIRED EXIT
- 2-HR RATED FIRE BARRIER (PARTITION)
- 1-HR RATED SMOKE BARRIER
- COMBINED 2-HR RATED FIRE BARRIER (PARTITION) AND SMOKE BARRIER

OCCUPANT LOAD
ACTUAL AREA
LOAD FACTOR
INDICATES ROOM OCCUPANCY INFO.
418 SF / 50 SF
[38.8 SM / 4.7 SM]

REVISIONS	DATE	CSHQ	C.W. MOORE PLAZA 250 S. 5TH ST. BOISE, IDAHO 83702 (208) 343-4635 FAX (208) 343-1858 http://www.cshqa.com	JOHN D. MAULIN, ARCHITECT C.W. MOORE PLAZA 250 S. 5TH ST. BOISE, IDAHO 83702 PHONE: 208-343-4635 FAX: 208-343-1858 THESE DRAWINGS AND SPECIFICATIONS, AS INSTRUMENTS OF SERVICE, ARE AND SHALL REMAIN THE PROPERTY OF THE ARCHITECT. ENGINEER WHETHER THE PROJECT FOR WHICH THEY ARE MADE IS EXECUTED OR NOT. THESE DRAWINGS AND SPECIFICATIONS SHALL NOT BE USED BY ANY PERSON OR ENTITY OTHER THAN THE PROJECT FOR WHICH THEY WERE PREPARED WITHOUT THE WRITTEN CONSENT OF CSQA OR ITS AFFILIATES. Copyright © 2013	STAMP LICENSED ARCHITECT AR 1706 ORIGINAL DOCUMENT SIGNED BY ARCHITECT ON FILE WITH THE OWNER ORIGINAL SIGNED BY: JOHN D. MAULIN DATE SIGNED: JULY 12, 2013 JULY 12, 2013	CAD FILE NAME: 531-320_G1.1.DWG XREF FILE NAME: 531-320_30X42TLBK.DWG 531-320_67A1.DWG	DRAWING TITLE FIRST FLOOR LIFE SAFETY PLANS	PROJECT TITLE BOISE VAMC BUILDING 67 EXPANSION	DATE 07/12/2013 PROJECT NO. 531-320 DRAWING NO. G1.1 DWG 02 OF 191	DEPARTMENT OF VETERANS AFFAIRS
APPROVED: CHIEF OF FACILITY MANAGEMENT SERVICE	APPROVED: MEDICAL CENTER DIRECTOR	BUILDING NUMBER 67	CHECKED JDM	DRAWN TWM	LOCATION VAMC BOISE, IDAHO					

CODE DATA:

CODES UTILIZED:

NFPA 101: LIFE SAFETY CODE, 2012 EDITION.

NFPA 220: STANDARD ON TYPES OF BUILDING CONSTRUCTION, 2012 EDITION.

FIRE PROTECTION FEATURES NOT ADDRESSED BY THE NFPA CODES SHALL COMPLY WITH THE 2009 INTERNATIONAL BUILDING CODE (IBC).

OCCUPANCY:

NEW HEALTHCARE OCCUPANCY, NFPA 101 CHAPTER 18.

SECOND FLOOR OCCUPANT LOAD:

179 PERSONS PER NFPA 101 38.1.7 AND TABLE 7.3.1.2.

TYPE OF CONSTRUCTION:

TYPE II (222)
PER NFPA 220, TABLE 4.1.1.

FIRE RESISTIVE RATINGS:

COLUMNS SUPPORTING FLOORS	=	2 HOUR
COLUMNS SUPPORTING ROOF	=	1 HOUR
FLOOR BEAMS	=	2 HOUR
FLOOR GIRDERS	=	2 HOUR
ROOF BEAMS & TRUSSES	=	1 HOUR
FLOOR & CEILING ASSEMBLIES	=	2 HOUR
ROOF & CEILING ASSEMBLIES	=	1 HOUR
INTERIOR NON-BEARING WALLS	=	NO RATING REQUIRED
EXTERIOR NON-BEARING WALLS	=	NO RATING REQUIRED
EXTERIOR BEARING WALLS	=	2 HOUR

CONSTRUCTION OF CORRIDOR WALLS:

NO FIRE RESISTANCE RATING SHALL BE REQUIRED FOR CORRIDOR WALLS PER NFPA 101 18.3.6.2.2.

FIRE ALARM SYSTEM:

THE BUILDING SHALL RECEIVE A FIRE ALARM SYSTEM BY THE CONTRACTOR.

FIRE SPRINKLER SYSTEM:



THE BUILDING SHALL BE SPRINKLED BY THE CONTRACTOR.

GENERAL NOTES

- A. NFPA 101 PRIMARILY ADDRESSES LIFE SAFETY AND FIRE PROTECTION FEATURES WHILE THE IBC ADDRESSES A WIDE RANGE OF CONSIDERATIONS, INCLUDING, BUT NOT LIMITED TO, STRUCTURAL STRENGTH, SEISMIC STABILITY, SANITATION, ADEQUATE LIGHT AND VENTILATION, AND ENERGY CONSERVATION. VA BUILDINGS MUST MEET THE REQUIREMENTS OF NFPA 101 AND DOCUMENTS REFERENCED BY NFPA 101 IN ORDER TO COMPLY WITH THE ACCREDITATION REQUIREMENTS OF THE JOINT COMMISSION. THEREFORE, DESIGNS SHALL COMPLY WITH THE REQUIREMENTS OF THE LATEST EDITION OF NFPA 101 AND DOCUMENTS REFERENCED THEREIN. DESIGN FEATURES NOT ADDRESSED BY NFPA 101 OR DOCUMENTS REFERENCED THEREIN SHALL COMPLY WITH THE REQUIREMENTS OF THE LATEST EDITION OF THE IBC. FOR DESIGN FEATURES THAT ARE ADDRESSED BY BOTH THE IBC AS WELL AS NFPA 101 OR A DOCUMENT REFERENCED BY NFPA 101, THE REQUIREMENTS OF NFPA 101 OR THE DOCUMENT REFERENCED BY NFPA 101 SHALL BE USED EXCLUSIVELY (THIS APPLIES EVEN IF THE IBC REQUIREMENTS ARE DIFFERENT).
- B. CONFLICTS BETWEEN NATIONALLY RECOGNIZED CODES AND STANDARDS AND VA REQUIREMENTS SHOULD A CONFLICT EXIST BETWEEN VA REQUIREMENTS AND VA ADOPTED NATIONALLY RECOGNIZED CODES AND STANDARDS, THE CONFLICT SHALL BE BROUGHT TO THE ATTENTION OF VA. THE RESOLUTION OF THE CONFLICT SHALL BE MADE BY THE AUTHORITY HAVING JURISDICTION FOR VA TO ENSURE A CONSISTENCY SYSTEM WIDE.
- C. PENETRATIONS THROUGH RATED ASSEMBLIES SHALL BE FIRESTOPPED IN ACCORDANCE WITH NFPA STANDARDS.
- D. CONTRACTOR TO MAINTAIN CONTINUITY OF ALL EXISTING RATED ASSEMBLIES UNTIL SUCH TIME THAT IT MAY BE REPLACED WITH NEW CONSTRUCTION, (I.E. DOORS ON STAIR TOWERS MAY NOT BE REMOVED UNTIL NEW DOORS ARE READY TO REPLACE THEM).

LEGEND:

- INDICATES PATH OF TRAVEL
- FE FIRE EXTINGUISHER AND CABINET
- FE BRACKET MOUNTED FIRE EXTINGUISHER
- EXIT INDICATES REQUIRED EXIT
- 1-HR RATED FIRE BARRIER (PARTITION) PER NFPA 18.3.2 AND TABLE 18.3.2.1 SEPARATING HAZARDOUS AREAS (STORAGE ROOMS GREATER THAN 100 SF AND SOILED LINEN ROOMS)
- 2-HR RATED FIRE BARRIER (PARTITION)
- 1-HR RATED SMOKE BARRIER PER NFPA 18.3.7.1 PROVIDING SMOKE COMPARTMENT ON STORIES USED FOR TREATMENT OF PATIENTS.
- COMBINED 2-HR RATED FIRE BARRIER (PARTITION) AND SMOKE BARRIER
- AREA OPEN TO EXIT CORRIDOR AS PART OF NURSES STATION PER NFPA 101 (2009 EDITION) 18.3.6.1 (3)
- AREA OPEN TO EXIT CORRIDOR WITH 24/7 SUPERVISION
- OCCUPANT LOAD
- ACTUAL AREA
- LOAD FACTOR
- INDICATES ROOM OCCUPANCY INFO.
- 418 SF / 50 SF
[38.8 SM / 4.7 SM]

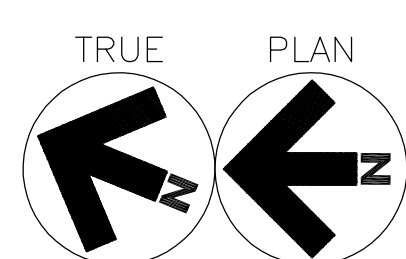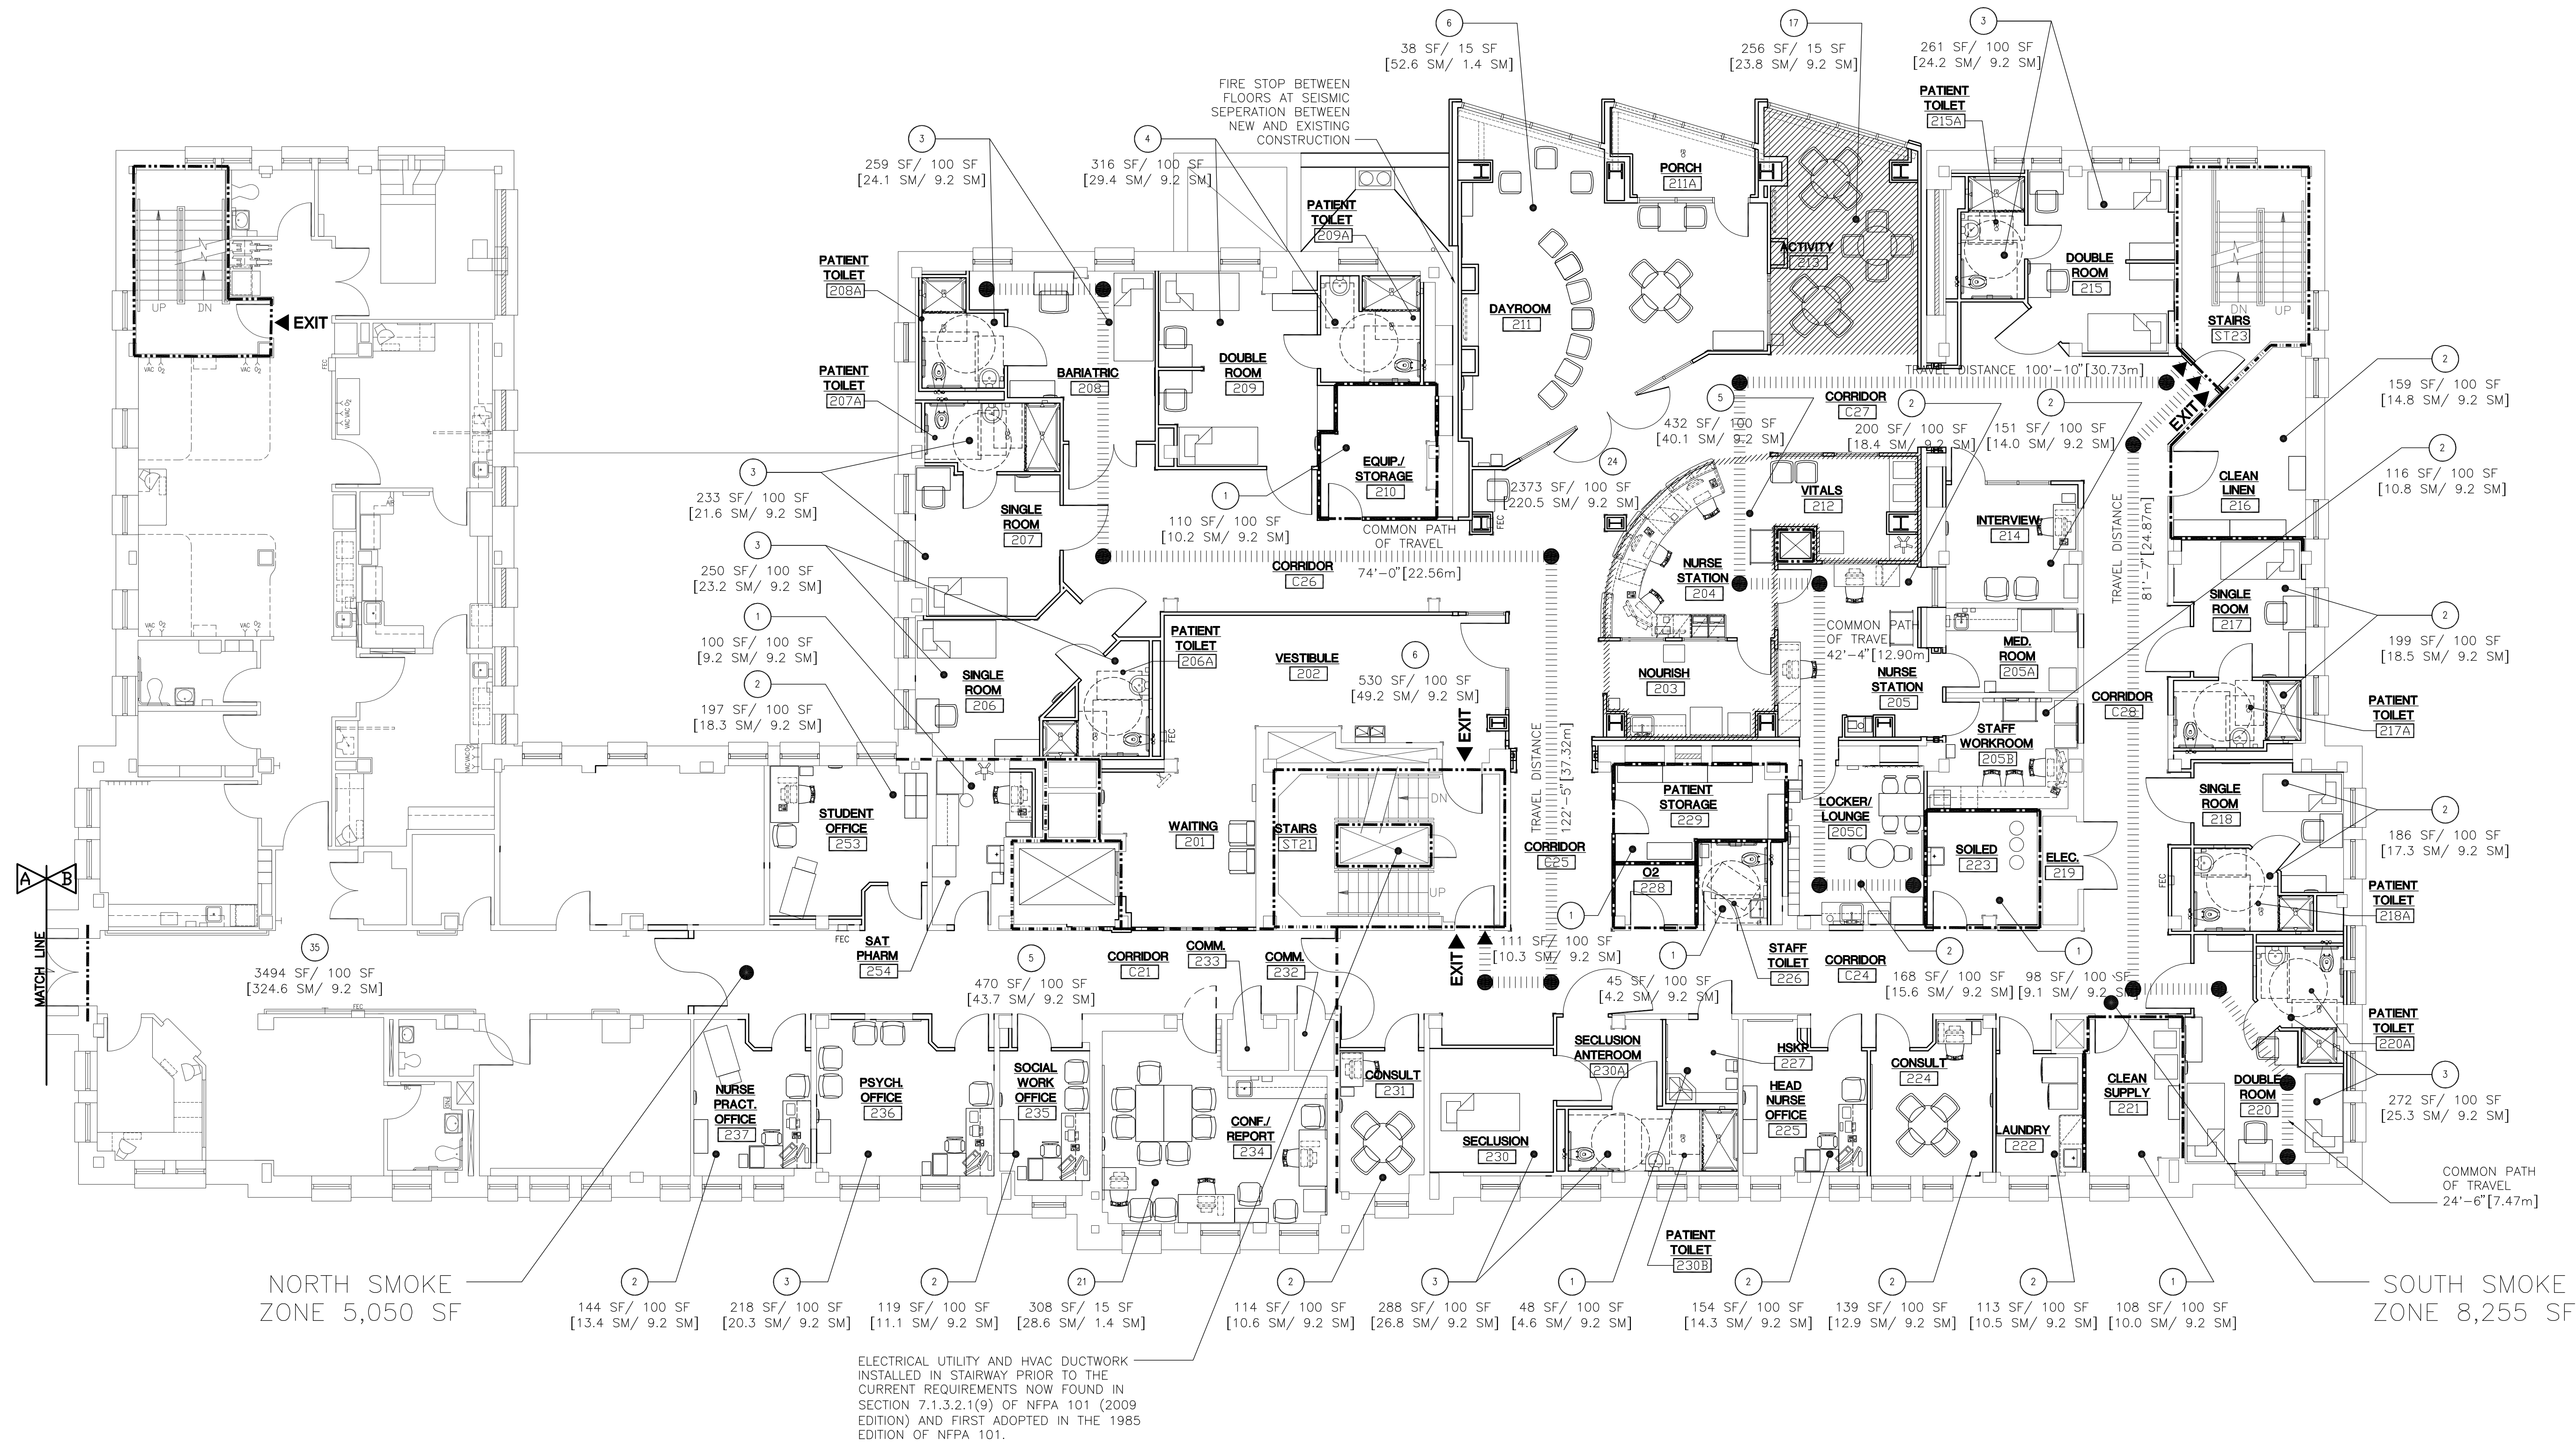

1 SECOND FLOOR LIFE SAFETY PLAN

SCALE: 1/8" = 1'-0"

AREA CALCULATIONS

SECOND FLOOR ADDITION NET AREA: 2,088 SQUARE FEET

SECOND FLOOR REMODEL NET AREA: 9,811 SQUARE FEET

SECOND FLOOR NET AREA: 13,305 SQUARE FEET

SECOND FLOOR GROSS AREA: 16,543 SQUARE FEET

APPLICABLE STANDARDS AND CODES

VA DIRECTIVES, DESIGN MANUALS, MASTER SPECIFICATIONS, VA BOISE MEDICAL CAD STANDARD APPLICATION GUIDE, AND OTHER GUIDANCE ON THE TECHNICAL INFORMATION LIBRARY (TIL)

INTERNATIONAL BUILDING CODE (IBC) 2009 EDITION (SEE CODE DATA AND NOTES)

NFPA 101 LIFE SAFETY CODE (LSC) 2012 EDITION (SEE CODE DATA AND NOTES)

NFPA NATIONAL FIRE CODES (SEE CODE DATA)

OCCUPATIONAL SAFETY AND HEALTH ADMINISTRATION (OSHA) STANDARDS

VA SEISMIC DESIGN REQUIREMENTS, H-18-B

NATIONAL ELECTRIC CODE (NEC)

NATIONAL STANDARD PLUMBING CODE (NSPC)

ASME BOILER AND PRESSURE VESSEL CODE

ASME CODE FOR PRESSURE PIPING

UNIFORM FEDERAL ACCESSIBILITY STANDARDS (UFAS) INCLUDING VA SUPPLEMENT, BARRIER FREE DESIGN

BUILDING CODE REQUIREMENTS FOR REINFORCED CONCRETE, AMERICAN CONCRETE INSTITUTE AND COMMENTARY

MANUAL OF STEEL CONSTRUCTION, LOAD AND RESISTANCE FACTOR DESIGN SPECIFICATIONS FOR STRUCTURAL

AMERICAN INSTITUTE OF STEEL CONSTRUCTION (AISC)

ENERGY POLICY ACT OF 2005 (EPACT)

DOE INTERIM FINAL RULE: ENERGY CONSERVATION STANDARDS FOR NEW FEDERAL, COMMERCIAL AND RESIDENTIAL BUILDINGS AND NEW LOW-RISE RESIDENTIAL BUILDINGS, 10 CFR PARTS 433, 434, AND 435.

FEDERAL LEADERSHIP IN HIGH PERFORMANCE AND SUSTAINABLE BUILDINGS: 2008 MEMORANDUM OF UNDERSTANDING

EXECUTIVE ORDER 13423: STRENGTHENING FEDERAL ENVIRONMENTAL, ENERGY, AND TRANSPORTATION AND US DEPARTMENT OF VETERANS AFFAIRS' GREEN BUILDINGS ACTION PLAN

THE PROVISIONS FOR CONSTRUCTION AND SAFETY SIGNS, STATED IN THE GENERAL REQUIREMENTS SECTION

ALL VA MASTER CONSTRUCTION SPECIFICATIONS.

VENTILATION FOR ACCEPTABLE INDOOR AIR QUALITY-- ASHRAE STANDARD 62.1-- 2004.

SAFETY STANDARD FOR REFRIGERATION SYSTEMS-- ASHRAE STANDARD 15 2007.

JOHN D. MAULIN, ARCHITECT

C.W. MOORE PLAZA
291 S. 5TH ST
BOISE, IDAHO
PHONE: 208-343-4635 FAX: 208-343-1858

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250 S. 6TH ST.
(208) 343-4635 FAX (208) 343-1858
http://www.cshqa.com

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LICENSED ARCHITECT
AR 1706
ORIGINAL DOCUMENT
SIGNED BY ARCHITECT ON
FILE WITH THE OWNER
ORIGINAL SIGNED BY:
JOHN D. MAULIN
ORIGINAL DATE SIGNED:
JULY 12, 2013
JOHN D. MAULIN
STATE OF IDAHO
JULY 12, 2013

CAD FILE NAME:
531-320_G1.2.DWG

XREF FILE NAME:
531-320_30X42TLBK.DWG
531-320_67A2.DWG

DRAWING TITLE
SECOND FLOOR
LIFE SAFETY PLANS

APPROVED: CHIEF OF FACILITY MANAGEMENT SERVICE

APPROVED: MEDICAL CENTER DIRECTOR

PROJECT TITLE
BOISE VAMC
BUILDING 67 EXPANSION

BUILDING NUMBER

67

CHECKED

JDM

DRAWN

TWM

LOCATION

VAMC BOISE, IDAHO

DATE

07/12/2013

PROJECT NO.

531-320

DRAWING NO.

G1.2

DWG

03 OF 191



DEPARTMENT OF VETERANS AFFAIRS

CODE DATA:

CODES UTILIZED:

NFPA 101: LIFE SAFETY CODE, 2012 EDITION.

NFPA 220: STANDARD ON TYPES OF BUILDING CONSTRUCTION, 2012 EDITION.

FIRE PROTECTION FEATURES NOT ADDRESSED BY THE NFPA CODES SHALL COMPLY WITH THE 2009 INTERNATIONAL BUILDING CODE (IBC).

OCCUPANCY:

NEW HEALTHCARE OCCUPANCY, NFPA 101 CHAPTER 18.

THIRD FLOOR OCCUPANT LOAD:

168 PERSONS PER NFPA 101 38.1.7 AND TABLE 7.3.1.2.

TYPE OF CONSTRUCTION:

TYPE II (222)
PER NFPA 220, TABLE 4.1.1.

FIRE RESISTIVE RATINGS:

COLUMNS SUPPORTING FLOORS	= 2 HOUR
COLUMNS SUPPORTING ROOF	= 1 HOUR
FLOOR BEAMS	= 2 HOUR
FLOOR GIRDERS	= 2 HOUR
ROOF BEAMS & TRUSSES	= 1 HOUR
FLOOR & CEILING ASSEMBLIES	= 2 HOUR
ROOF & CEILING ASSEMBLIES	= 1 HOUR
INTERIOR NON-BEARING WALLS	= NO RATING REQUIRED
EXTERIOR NON-BEARING WALLS	= NO RATING REQUIRED
EXTERIOR BEARING WALLS	= 2 HOUR

CONSTRUCTION OF CORRIDOR WALLS:

NO FIRE RESISTANCE RATING SHALL BE REQUIRED FOR CORRIDOR WALLS PER NFPA 101 18.3.6.2.2.

FIRE ALARM SYSTEM:

THE BUILDING SHALL RECEIVE A FIRE ALARM SYSTEM BY THE CONTRACTOR.

FIRE SPRINKLER SYSTEM:

THE BUILDING SHALL BE SPRINKLED BY THE CONTRACTOR



GENERAL NOTES

- A. NFPA 101 PRIMARILY ADDRESSES LIFE SAFETY AND FIRE PROTECTION FEATURES WHILE THE IBC ADDRESSES A WIDE RANGE OF CONSIDERATIONS, INCLUDING, BUT NOT LIMITED TO, STRUCTURAL STRENGTH, SEISMIC STABILITY, SANITATION, ADEQUATE LIGHT AND VENTILATION, AND ENERGY CONSERVATION. VA BUILDINGS MUST MEET THE REQUIREMENTS OF NFPA 101 AND DOCUMENTS REFERENCED BY NFPA 101 IN ORDER TO COMPLY WITH THE ACCREDITATION REQUIREMENTS OF THE JOINT COMMISSION. THEREFORE, DESIGNS SHALL COMPLY WITH THE REQUIREMENTS OF THE LATEST EDITION OF NFPA 101 AND DOCUMENTS REFERENCED THEREIN. DESIGN FEATURES NOT ADDRESSED BY NFPA 101 OR DOCUMENTS REFERENCED THEREIN SHALL COMPLY WITH THE REQUIREMENTS OF THE LATEST EDITION OF THE IBC. FOR DESIGN FEATURES THAT ARE ADDRESSED BY BOTH THE IBC AS WELL AS NFPA 101 OR A DOCUMENT REFERENCED BY NFPA 101, THE REQUIREMENTS OF NFPA 101 OR THE DOCUMENT REFERENCED BY NFPA 101 SHALL BE USED EXCLUSIVELY (THIS APPLIES EVEN IF THE IBC REQUIREMENTS ARE DIFFERENT).
- B. CONFLICTS BETWEEN NATIONALLY RECOGNIZED CODES AND STANDARDS AND VA REQUIREMENTS SHOULD A CONFLICT EXIST BETWEEN VA REQUIREMENTS AND VA ADOPTED NATIONALLY RECOGNIZED CODES AND STANDARDS, THE CONFLICT SHALL BE BROUGHT TO THE ATTENTION OF VA. THE RESOLUTION OF THE CONFLICT SHALL BE MADE BY THE AUTHORITY HAVING JURISDICTION FOR VA TO ENSURE A CONSISTENCY SYSTEM WIDE.
- C. PENETRATIONS THROUGH RATED ASSEMBLIES SHALL BE FIRESTOPPED IN ACCORDANCE WITH NFPA STANDARDS.
- D. CONTRACTOR TO MAINTAIN CONTINUITY OF ALL EXISTING RATED ASSEMBLIES UNTIL SUCH TIME THAT IT MAY BE REPLACED WITH NEW CONSTRUCTION. (I.E. DOORS ON STAIR TOWERS MAY NOT BE REMOVED UNTIL NEW DOORS ARE READY TO REPLACE THEM).

LEGEND:

- INDICATES PATH OF TRAVEL
FEC FIRE EXTINGUISHER AND CABINET
FE BRACKET MOUNTED FIRE EXTINGUISHER
EXIT INDICATES REQUIRED EXIT
1-HR RATED FIRE BARRIER (PARTITION) PER NFPA 18.3.2 AND TABLE 18.3.2.1 SEPARATING HAZARDOUS AREAS (STORAGE ROOMS GREATER THAN 100 SF AND SOILED LINEN ROOMS)
2-HR RATED FIRE BARRIER (PARTITION)
1-HR RATED SMOKE BARRIER PER NFPA 18.3.7.1 PROVIDING SMOKE COMPARTMENT ON STORIES USED FOR TREATMENT OF PATIENTS.
COMBINED 2-HR RATED FIRE BARRIER (PARTITION) AND SMOKE BARRIER
AREA OPEN TO EXIT CORRIDOR AS PART OF NURSES STATION PER NFPA 101 (2009 EDITION) 18.3.6.1 (3)
AREA OPEN TO EXIT CORRIDOR WITH 24/7 SUPERVISION
SPACE OPEN TO EXIT CORRIDOR ALLOWABLE UNDER NFPA 101 (2009 EDITION) 19.3.6.1(1). COVERED BY SMOKE DETECTOR

- OCCUPANT LOAD
ACTUAL AREA
LOAD FACTOR
INDICATES ROOM OCCUPANCY INFO.
418 SF / 50 SF
[38.8 SM / 4.7 SM]

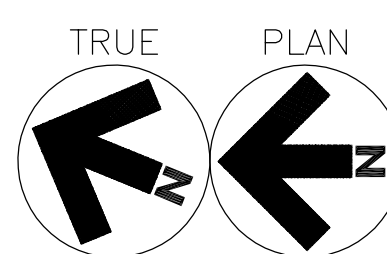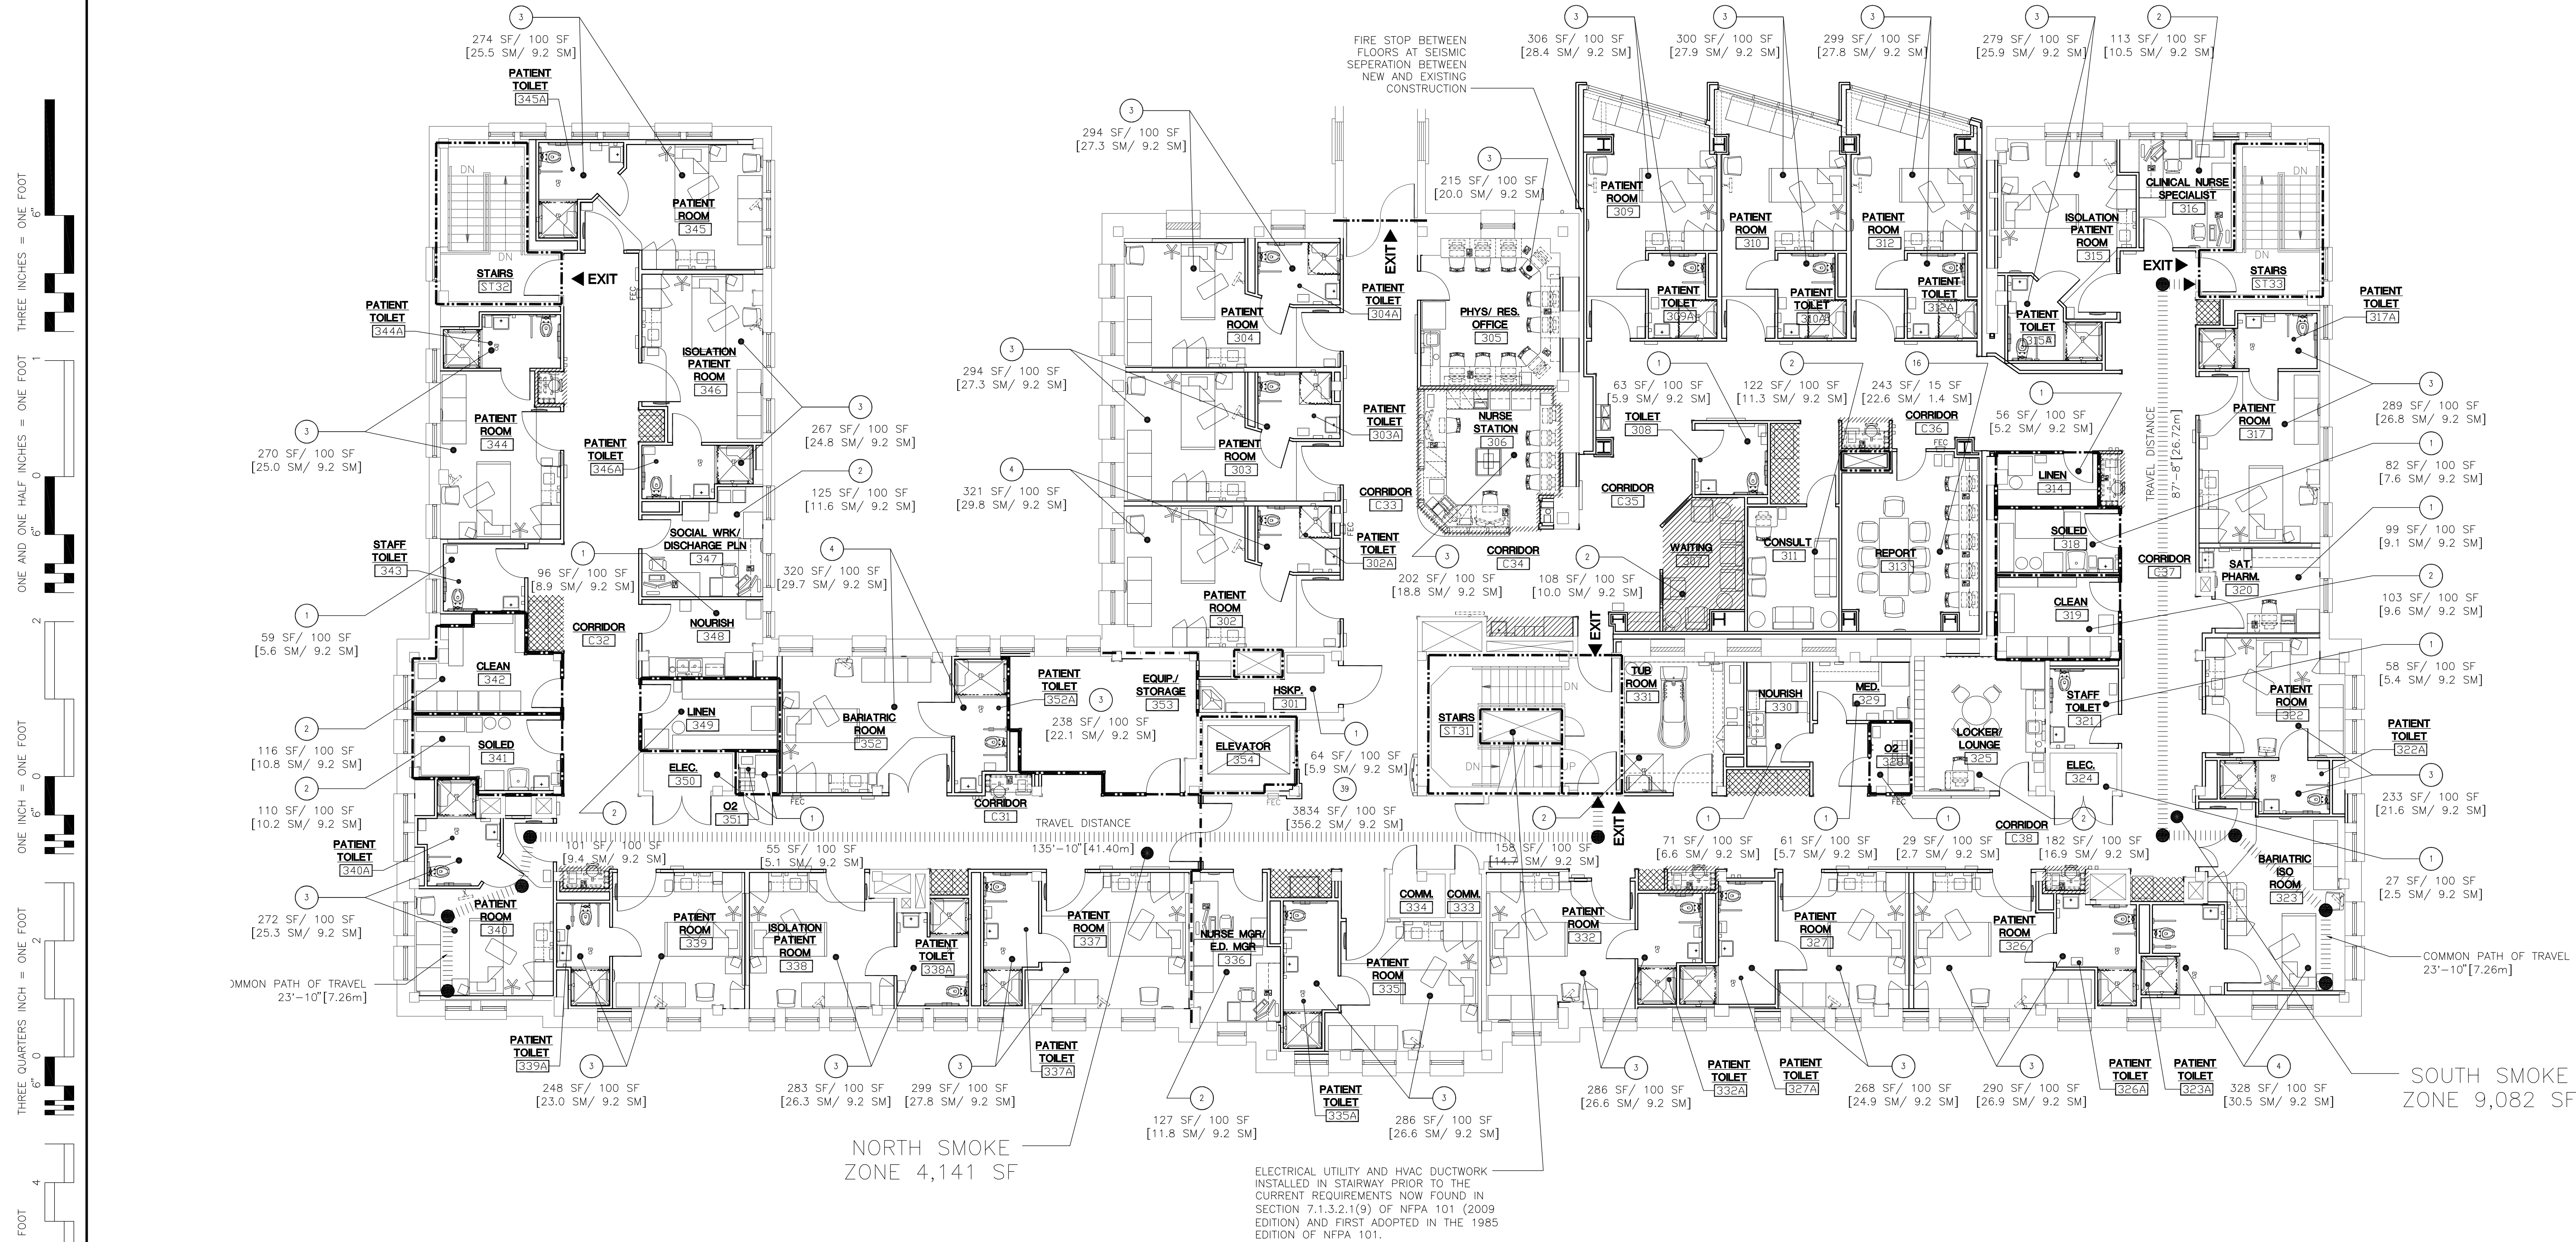

1 THIRD FLOOR LIFE SAFETY PLAN

SCALE: 1/8" = 1'-0"

AREA CALCULATIONS

THIRD FLOOR ADDITION NET AREA: 2,088 SQUARE FEET

THIRD FLOOR REMODEL NET AREA: 13,223 SQUARE FEET

THIRD FLOOR NET AREA: 13,223 SQUARE FEET

THIRD FLOOR GROSS AREA: 16,541 SQUARE FEET

APPLICABLE STANDARDS AND CODES

VA DIRECTIVES, DESIGN MANUALS, MASTER SPECIFICATIONS, VA BOISE MEDICAL CAD STANDARD APPLICATION GUIDE, AND OTHER GUIDANCE ON THE TECHNICAL INFORMATION LIBRARY (TIL)

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NFPA NATIONAL FIRE CODES (SEE CODE DATA)

OCCUPATIONAL SAFETY AND HEALTH ADMINISTRATION (OSHA) STANDARDS

VA SEISMIC DESIGN REQUIREMENTS, H-18-8

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NATIONAL STANDARD PLUMBING CODE (NSPC)

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AMERICAN INSTITUTE OF STEEL CONSTRUCTION (AISC)

ENERGY POLICY ACT OF 2005 (EPACT)

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LICENSED ARCHITECT
AR-1708
ORIGINAL DOCUMENT
SIGNED BY ARCHITECT ON
FILE WITH THE OWNER
ORIGINAL SIGNED BY:
JOHN D. MAULIN
DATE SIGNED:
JULY 12, 2013
JOHN D. MAULIN
STATE OF IDAHO
JULY 12, 2013

CAD FILE NAME:

531-320_G1.3.DWG

XREF FILE NAME:

531-320_30X42TLBK.DWG
531-320_67A1.DWG
531-320_67A2.DWG
531-320_67A3.DWG

DRAWING TITLE

THIRD FLOOR
LIFE SAFETY PLANS

APPROVED: CHIEF OF FACILITY MANAGEMENT SERVICE

APPROVED: MEDICAL CENTER DIRECTOR

PROJECT TITLE

BOISE VAMC
BUILDING 67 EXPANSION

BUILDING NUMBER

67

LOCATION

VAMC BOISE, IDAHO

DATE

07/12/2013

PROJECT NO.

531-320

DRAWING NO.

G1.3

DWG



04 OF 191



DEPARTMENT OF VETERANS AFFAIRS

GENERAL NOTES

- A. TEMPORARY BARRIERS MUST BE CONSTRUCTED FOR ALL OCCUPANCIES WHEREVER CORRIDOR WALLS OR FIRE WALLS ARE IMPACTED BY CONSTRUCTION. TEMPORARY WALLS THAT SEPARATE RENOVATION PROJECTS FROM OCCUPIED AREAS MUST BE OF 1-HOUR CONSTRUCTION (METAL STUDS AT 24" O.C. WITH 5/8" FIRE TAPED TYPE X SHEETROCK ON EACH SIDE) WITH 90 MINUTE RATED DOORS. TEMPORARY RATED PARTITIONS MUST RUN FROM SLAB TO SLAB AND FROM EXTERIOR WALL OR FIRE RATED PARTITION TO EXTERIOR WALL OR FIRE RATED PARTITION. FIREBRICKS OR FIRE PLUGS MUST BE USED TO SEAL PENETRATIONS IN TEMPORARY OR PERMANENT FIRE SEPARATIONS UNTIL THEY CAN BE PROPERLY SEALED (I.E. CORE DRILLS FOR NEW SEWER LINES PRIOR TO INSTALLATION AND FIRE CAULKING OF SEWER LINES). INSTALL BARRIER PRIOR TO COMMENCING DEMOLITION AND CONSTRUCTION OF EACH AFFECTED PHASE. REMOVE BARRIER WHEN DIRECTED BY COTR.
- B. WHEN PLASTIC SHEETING IS USED TO SEPARATE AREAS UNDER CONSTRUCTION FROM THE REMAINDER OF A BUILDING FOR DUST OR ACCESS CONTROL, THE PLASTIC SHEETING MUST BE FIRE RESISTANT (LIMITED COMBUSTIBILITY). THE DOES NOT CHANGE THE REQUIREMENT TO BUILD TEMPORARY BARRIERS OF METAL STUDS AND GYPSUM BOARD.

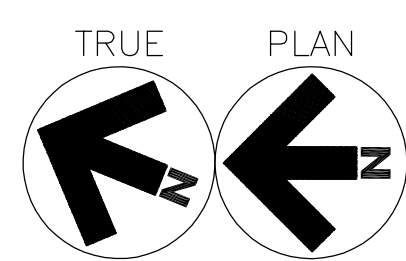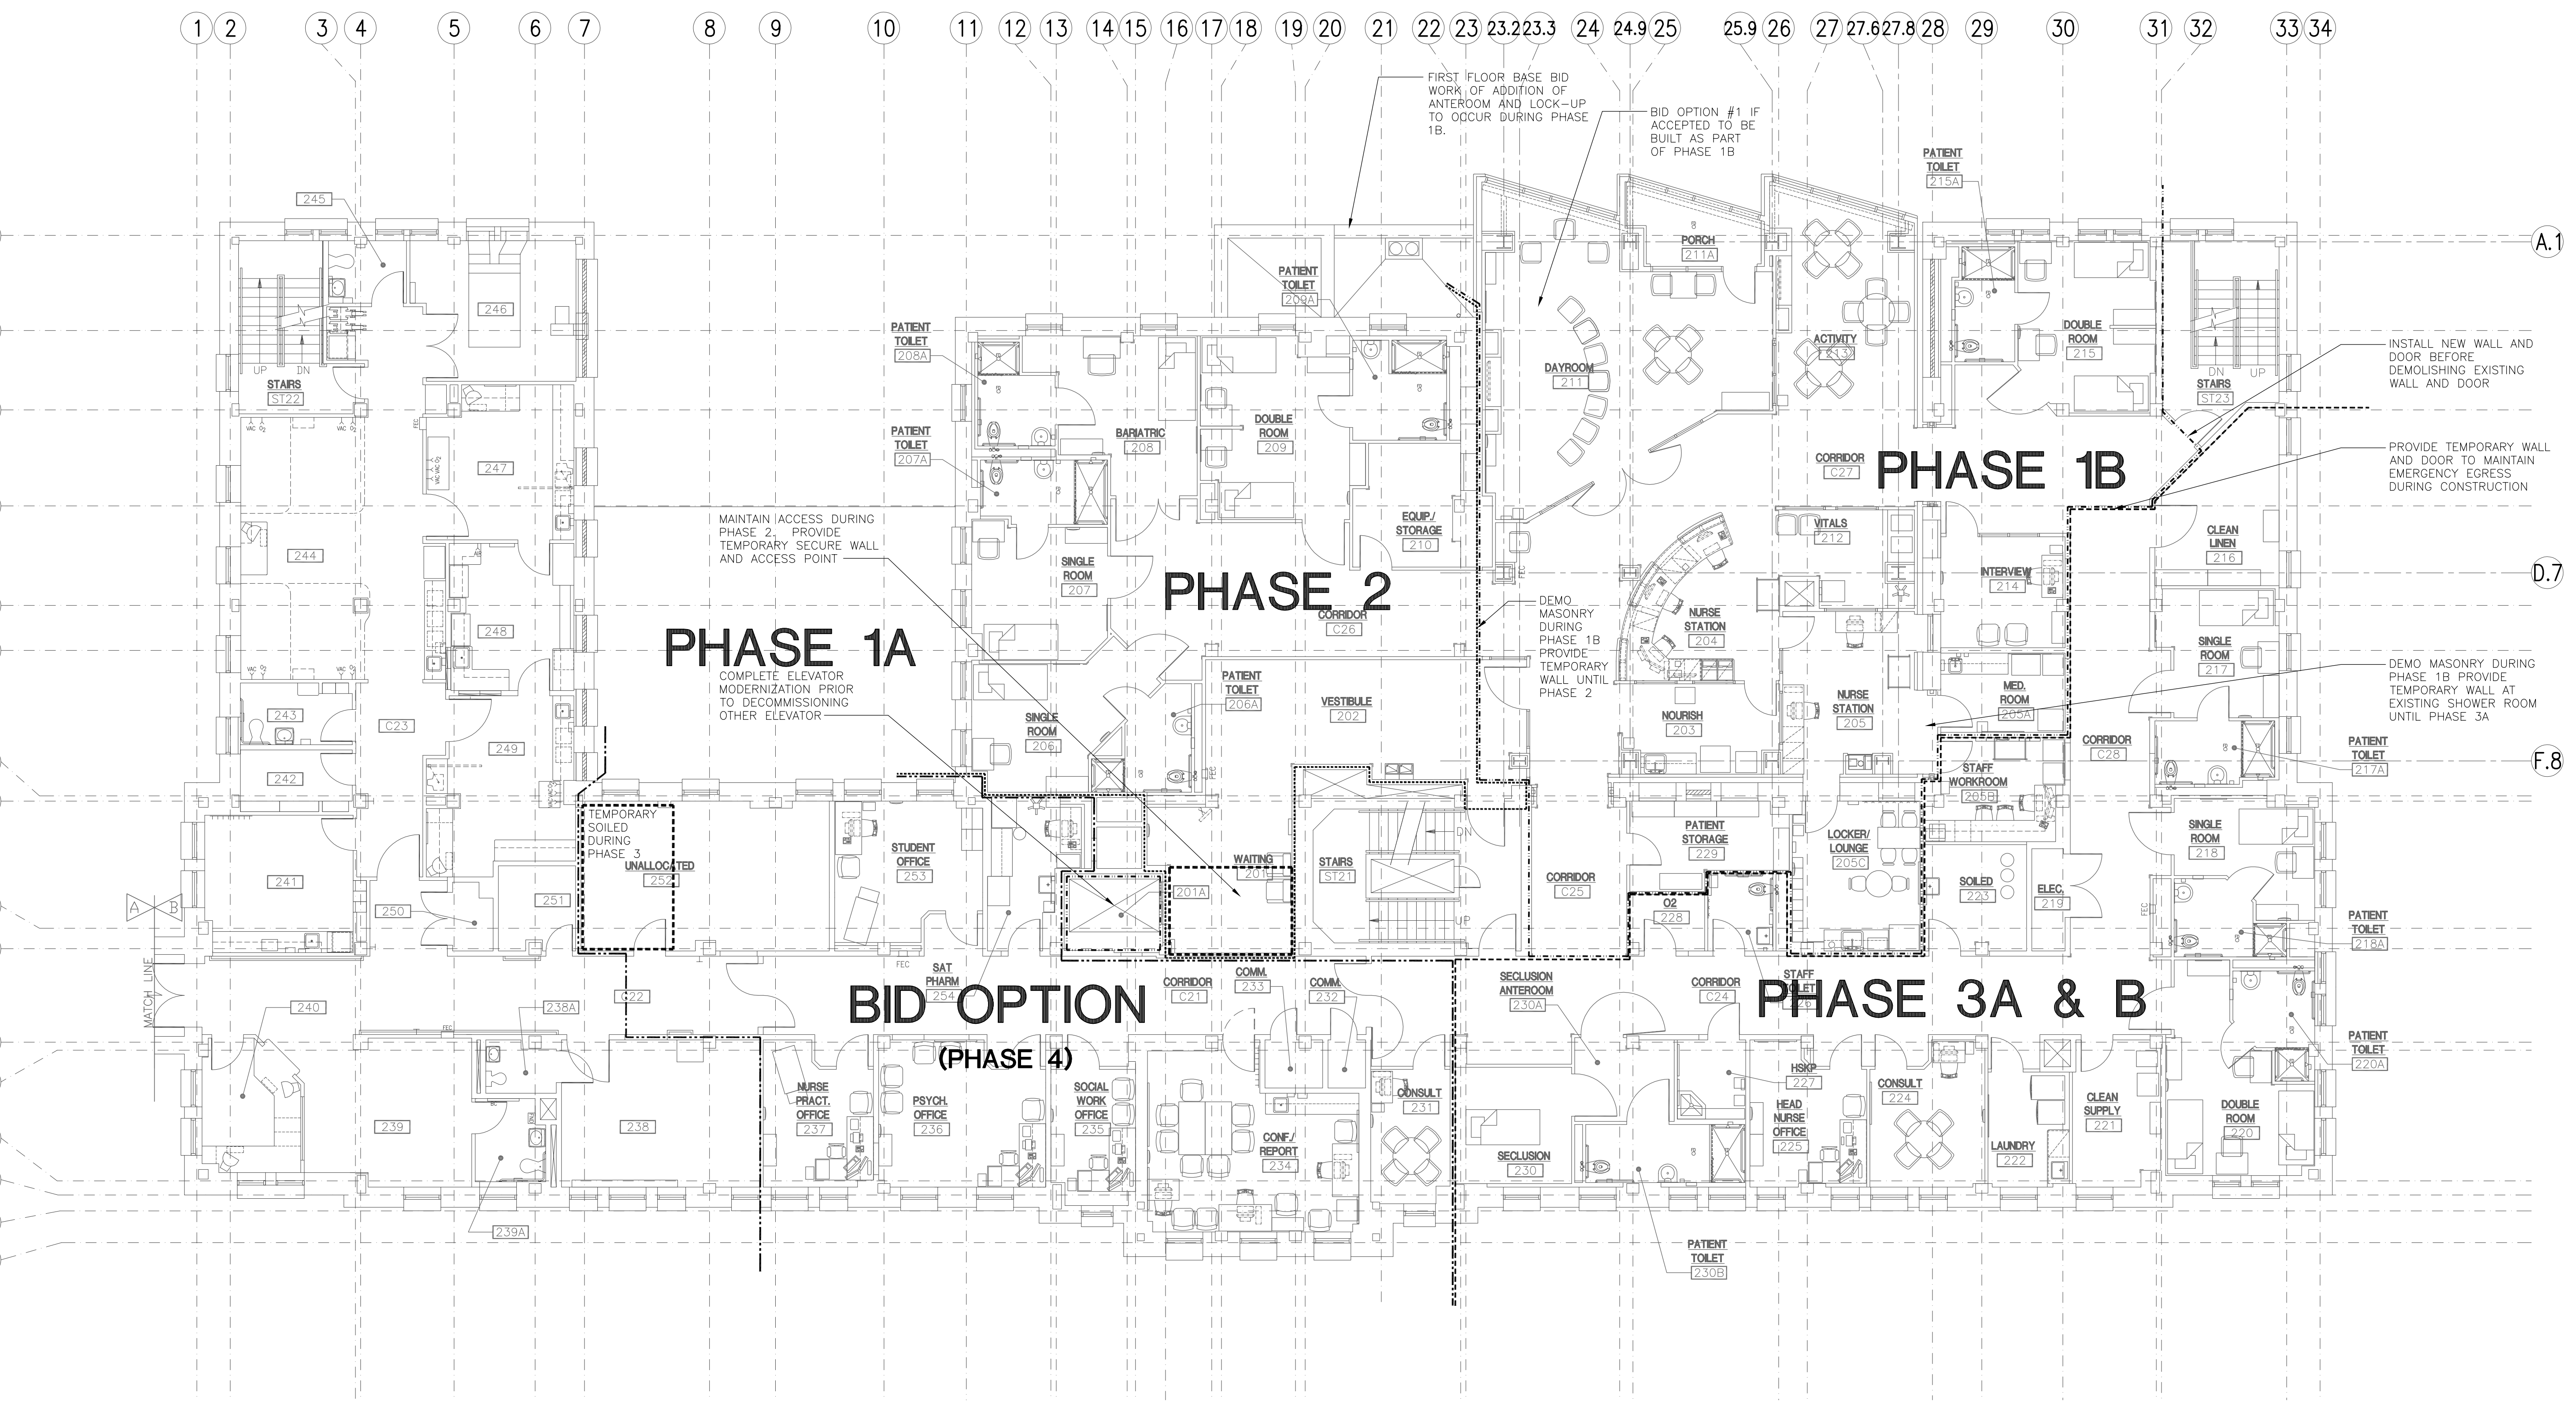

1 SECOND FLOOR PHASING PLAN


SCALE: 1/8" = 1'-0"

ONE EIGHTH INCH = ONE FOOT
ONE QUARTER INCH = ONE FOOT
THREE EIGHTHS INCH = ONE FOOT
ONE HALF INCH = ONE FOOT
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ONE INCH = ONE FOOT
ONE AND ONE HALF INCHES = ONE FOOT
TWO INCHES = ONE FOOT
THREE INCHES = ONE FOOT

<div> <div>REVISIONS</div> <div>DATE</div> </div>	<div> <div>CSHQ</div> <div> <div>C.W. MOORE PLAZA</div> <div>250 S. 5TH ST. BOISE, ID 83702</div> <div>(208) 343-4635 FAX (208) 343-1858</div> <div>http://www.cshqa.com</div> </div> </div>	<div> <div>JOHN D. MAULIN, ARCHITECT</div> <div> <div>C.W. MOORE PLAZA</div> <div>250 S. 5TH ST. BOISE, IDAHO</div> <div>PHONE: 208-343-4635 FAX: 208-343-1858</div> </div> </div>	<div> <div>STAMP</div> <div> <div>LICENSED ARCHITECT</div> <div>AR-1106</div> <div>ORIGINAL DOCUMENT</div> <div>SIGNED BY ARCHITECT ON</div> <div>FILE WITH THE OWNER</div> <div>ORIGINAL SIGNED BY: JOHN D. MAULIN</div> <div>ORIGINAL DATE SIGNED: JULY 12, 2013</div> <div>AND D. MAULIN</div> <div>STATE OF IDAHO</div> <div>JULY 12, 2013</div> </div> </div>	<div> <div>CAD FILE NAME:</div> <div>531-320_G1.4.DWG</div> <div>XREF FILE NAME:</div> <div>531-320_30X42TLBK.DWG</div> <div>531-320_67A2.DWG</div> </div>	<div> <div>DRAWING TITLE</div> <div>SECOND FLOOR PHASING PLAN</div> <div>APPROVED: CHIEF OF FACILITY MANAGEMENT SERVICE</div> <div>APPROVED: MEDICAL CENTER DIRECTOR</div> </div>	<div> <div>PROJECT TITLE</div> <div>BOISE VAMC BUILDING 67 EXPANSION</div> <div>BUILDING NUMBER</div> <div>67</div> <div>LOCATION</div> <div>VAMC BOISE, IDAHO</div> </div>	<div> <div>DATE</div> <div>07/12/2013</div> <div>PROJECT NO.</div> <div>531-320</div> <div>DRAWING NO.</div> <div>G1.4</div> <div>DWG</div> <div>05 OF 191</div> </div>	<div> <div>DEPARTMENT OF VETERANS AFFAIRS</div> </div>
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GENERAL NOTES

- A. TEMPORARY BARRIERS MUST BE CONSTRUCTED FOR ALL OCCUPANCIES WHEREVER CORRIDOR WALLS OR FIRE WALLS ARE IMPACTED BY CONSTRUCTION. TEMPORARY WALLS THAT SEPARATE RENOVATION PROJECTS FROM OCCUPIED AREAS MUST BE OF 1-HOUR CONSTRUCTION (METAL STUDS AT 24" O.C. WITH 5/8" FIRE TAPED TYPE X SHEETROCK ON EACH SIDE) WITH 90 MINUTE RATED DOORS. TEMPORARY RATED PARTITIONS MUST RUN FROM SLAB TO SLAB AND FROM EXTERIOR WALL OR FIRE RATED PARTITION TO EXTERIOR WALL OR FIRE RATED PARTITION. FIREBRICKS OR FIRE PLUGS MUST BE USED TO SEAL PENETRATIONS IN TEMPORARY OR PERMANENT FIRE SEPARATIONS UNTIL THEY CAN BE PROPERLY SEALED (I.E. CORE DRILLS FOR NEW SEWER LINES PRIOR TO INSTALLATION AND FIRE CAULKING OF SEWER LINES). INSTALL BARRIER PRIOR TO COMMENCING DEMOLITION AND CONSTRUCTION OF EACH AFFECTED PHASE. REMOVE BARRIER WHEN DIRECTED BY COTR.
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1 THIRD FLOOR PHASING PLAN

SCALE: 1/8" = 1'-0"

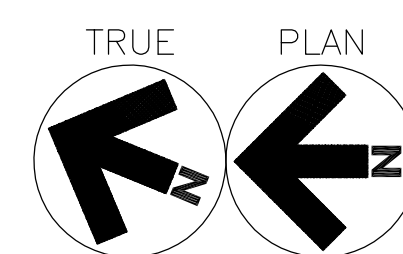JOHN D. MAULIN, ARCHITECT

C.W. MOORE PLAZA
290 S. 5TH ST.
BOISE, IDAHO
PHONE: 208-343-4635 FAX: 208-343-1858

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250 S. 5TH ST.
BOISE, IDAHO 83702
(208) 343-4635 FAX (208) 343-1858
http://www.cshqa.com

STAMP

LICENSED ARCHITECT
AR-1106
ORIGINAL DOCUMENT
SIGNED BY ARCHITECT ON
FILE WITH THE OWNER
ORIGINAL SIGNED BY:
JOHN D. MAULIN
ORIGINAL DATE SIGNED:
JULY 12, 2013
JOHN D. MAULIN
STATE OF IDAHO
JULY 12, 2013

CAD FILE NAME:
531-320_G1.5.DWG

XREF FILE NAME:
531-320_30X42TLBK.DWG
531-320_67A3.DWG

DRAWING TITLE
THIRD FLOOR
PHASING PLAN

APPROVED: CHIEF OF FACILITY MANAGEMENT SERVICE

APPROVED: MEDICAL CENTER DIRECTOR

PROJECT TITLE
BOISE VAMC
BUILDING 67 EXPANSION

BUILDING NUMBER
67

LOCATION
VAMC BOISE, IDAHO

CHECKED
JDM


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TWM

DATE
07/12/2013

PROJECT NO.
531-320


DRAWING NO.
G1.5

DWG 06 OF 191

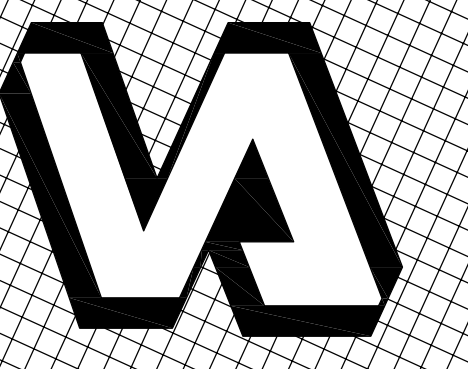

DEPARTMENT OF VETERANS AFFAIRS

ONE EIGHTH INCH = ONE FOOT
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ONE AND ONE HALF INCHES = ONE FOOT
TWO INCHES = ONE FOOT
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- LEGEND**
- GUARD RAIL
 - EDGE OF DIRT ROAD
 - EDGE OF GRAVEL
 - EDGE OF GRASS
 - FLOW LINE
 - EXISTING SIGNAL LINE
 - EXISTING FIBER OPTIC LINE
 - FIRE LINE EXISTING AND FROM RECORDS MAPS
 - GEOTHERMAL WATER FROM RECORD MAPS
 - EXISTING OVERHEAD POWER LINE
 - EXISTING UNDERGROUND POWER LINE
 - EXISTING UNDERGROUND COMMUNICATIONS LINE
 - EXISTING STORM DRAIN LINE
 - EXISTING SEWER LINE
 - PAINT STRIPE
 - TIE/DETAIL LINE

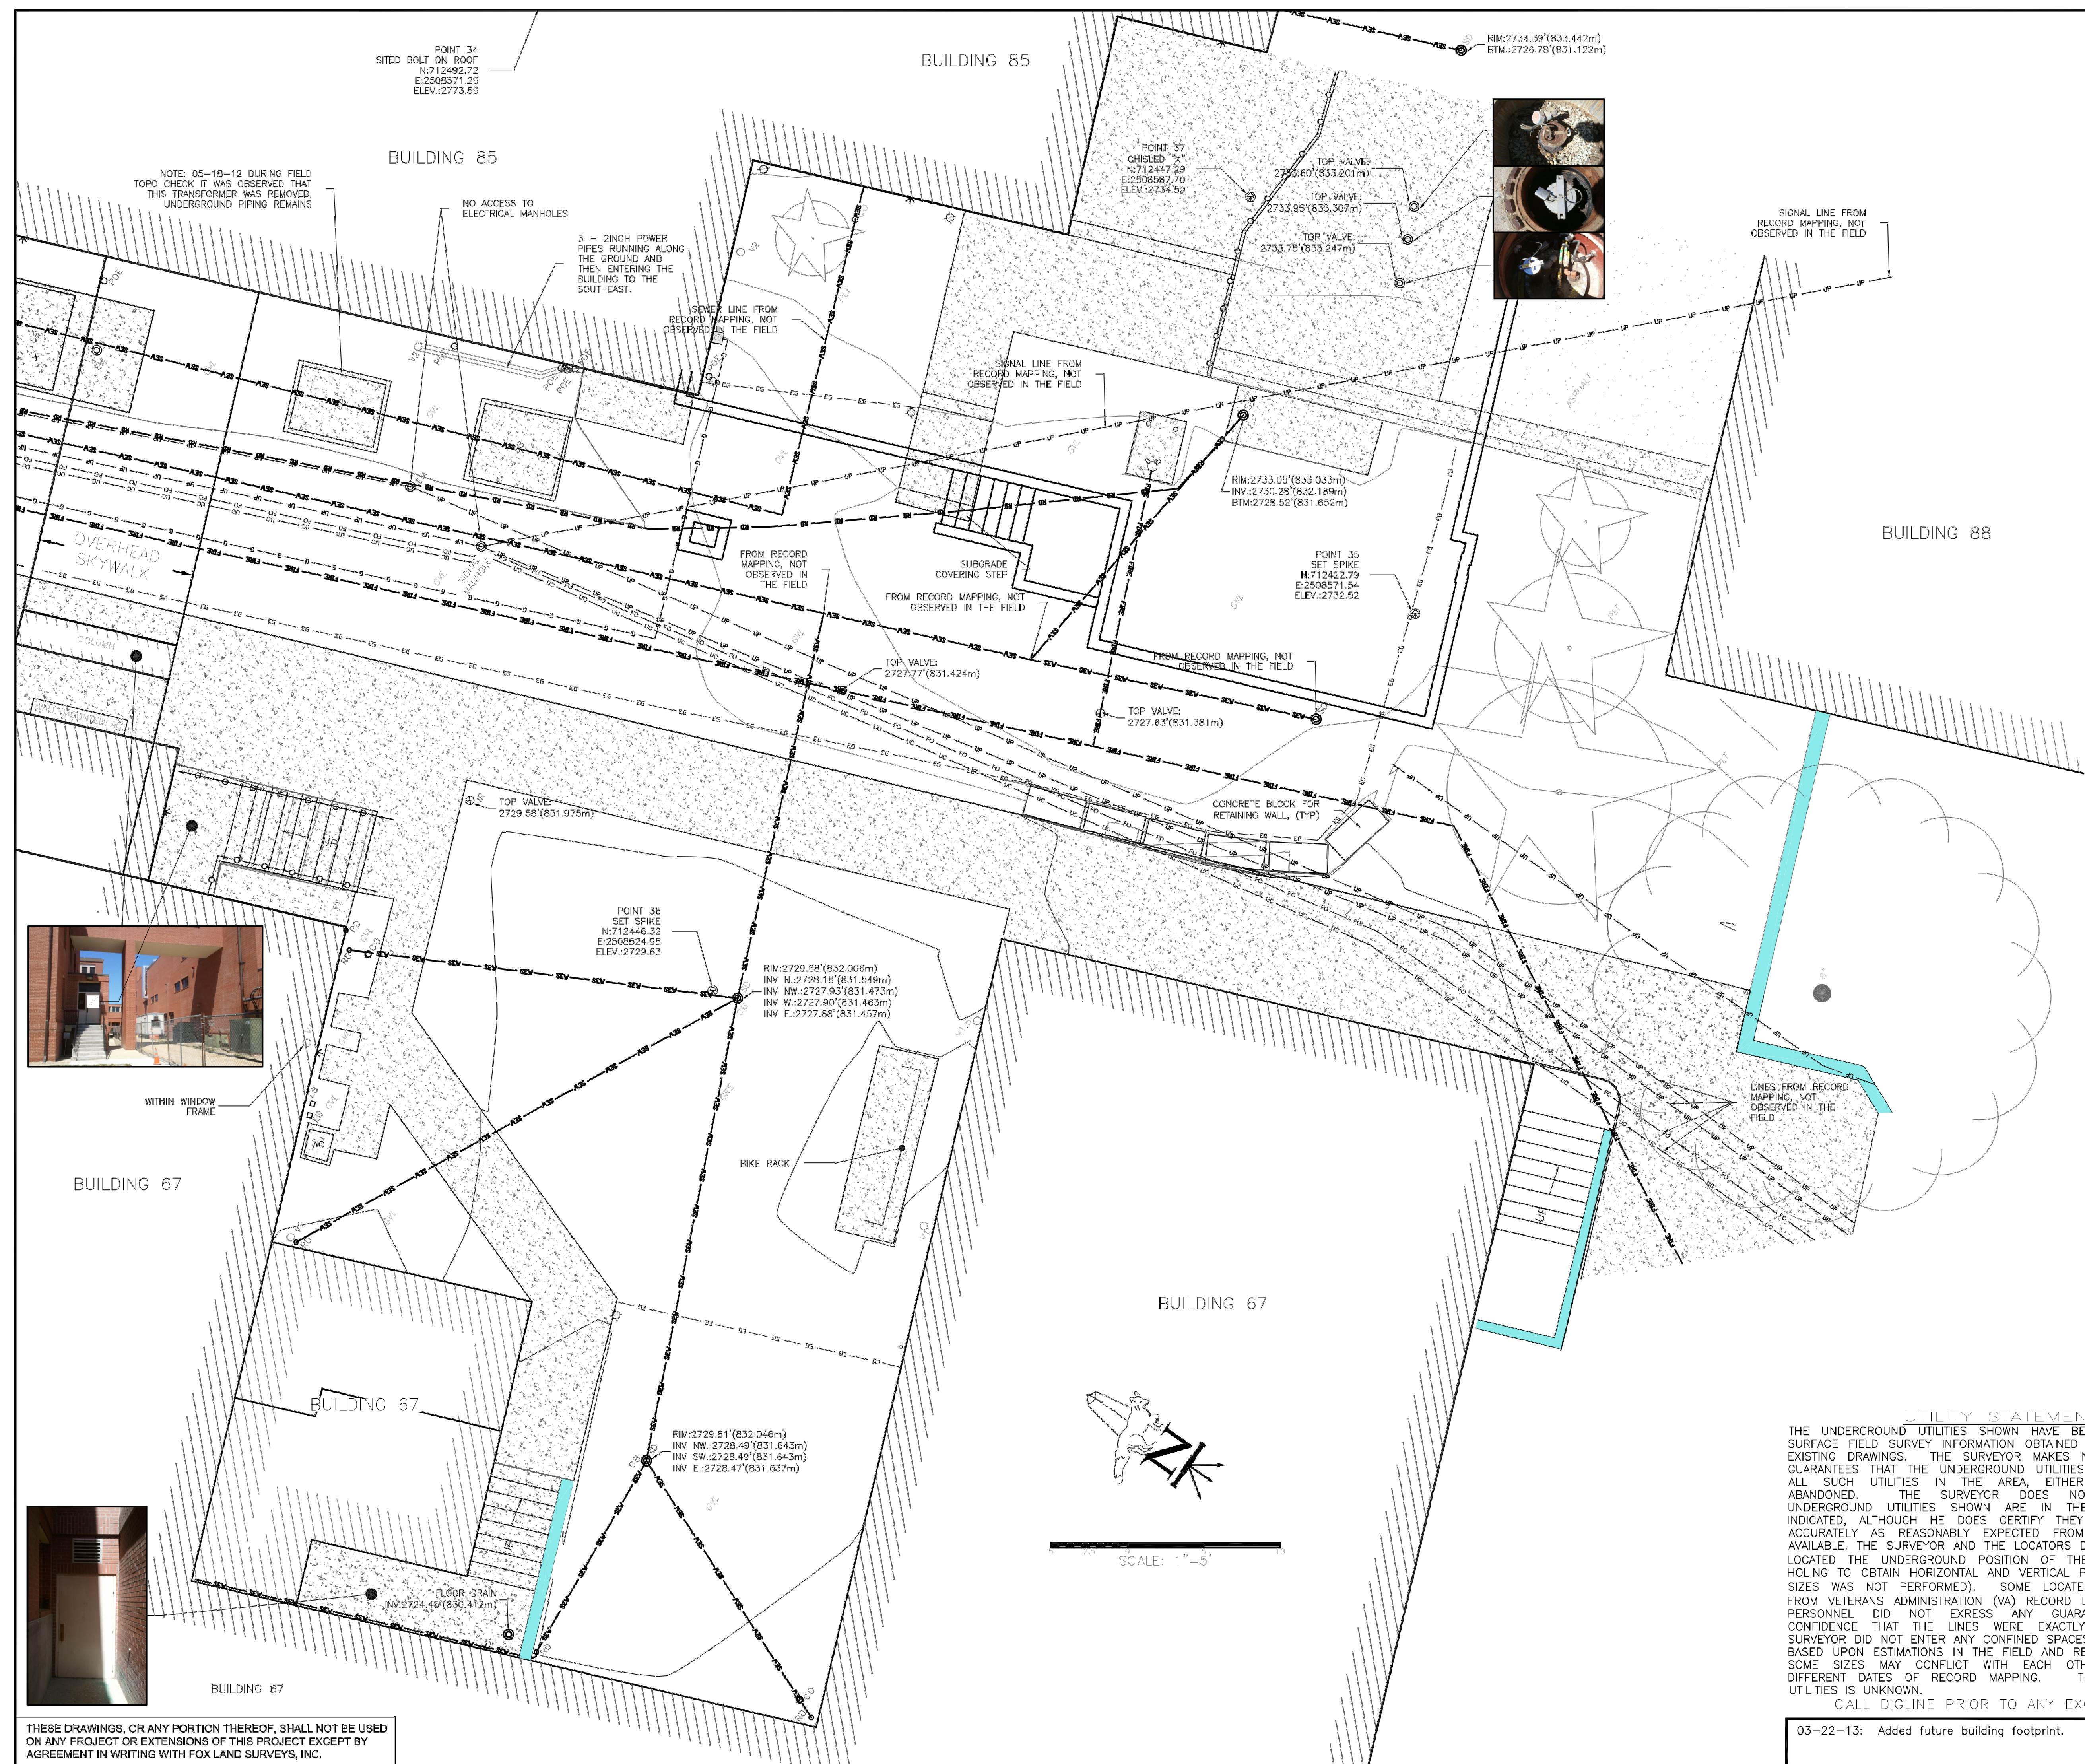- SURVEY CONTROL POINT (AS NOTED)
- EXISTING SIGN
- EXISTING HANDICAP PARKING SIGN
- LIGHT
- ELECTRIC MANHOLE
- EMERGENCY SIGNAL
- ELECTRICAL BOX
- POINT OF ENTRY UNDERGROUND ELECTRIC
- WATER VALVE
- FIRE HYDRANT
- WATER SPIGOT
- FUEL MANHOLE
- MONITOR WELL
- IRRIGATION VALVE
- VERTICAL PIPE (NUMBER DENOTES SIZE IN INCHES)
- SANITARY SEWER CLEANOUT
- SANITARY SEWER CLEANOUT
- STORM DRAIN MANHOLE
- CATCH BASIN
- ROOF DRAIN
- PIPE/LINE TERMINUS UNKNOWN
- BOLLARD
- DECIDUOUS TREE, DIAMETER IN INCHES, CANOPY DRAWN TO SCALE
- CONIFEROUS TREE, DIAMETER IN INCHES, CANOPY DRAWN TO SCALE
- BUSH, DRAWN TO SCALE
- ASPHALT
- CONCRETE
- WALL
- AIR
- BENCH
- CMP
- ESMT
- CVL
- PNT
- PVC
- RMP
- AIR CONDITIONING UNIT
- CORRUGATED METAL PIPE
- EASEMENT
- GRAVEL
- POINT
- POLYVINYL CHLORIDE PIPE
- RAMP

BASIS OF BEARING
THE BASIS OF BEARINGS FOR THIS SURVEY WAS ESTABLISHED BY GPS TECHNIQUES, PROJECTED TO THE IDAHO STATE PLANE COORDINATE SYSTEM, NAD 83 DATUM, WEST ZONE. ALL BEARINGS SHOWN ARE ON GRID AZIMUTH AND ALL DISTANCES SHOWN ARE AT GROUND. THE BEARING FROM THE FOUND BRASS CAP MONUMENT MARKING AN ANGLE POINT IN THE NORTH BOUNDARY OF THE "VETERANS HOME" PARCEL (SET BY THE GENERAL LAND OFFICE) TO THE 5/8 INCH REBAR WITH CAP STAMPED "SS PL512461" MARKING THE NORTHEAST CORNER OF SAID PARCEL IS SOUTH 87°16'56" EAST, A GROUND DISTANCE OF 516.22'.

BENCHMARK & COORDINATE DERIVATION
(NAVD 88)
THE REFERENCE BENCHMARK FOR THIS SURVEY IS THE REFERENCE STATION OPERATED BY BONNEVILLE BLUEPRINT, VALIDATED AGAINST THE FOLLOWING CORS SITES:

PID#	NAME
AF9836	OWEN APPLETON
AJ1822	SPokane
DE8232	MSOL MISSOULA

REFER TO DRAWING FOR ON-SITE CONTROL VALUES. CONFIRMATION OF ON-SITE BENCHMARKS MUST BE CHECKED WITH A SECOND ON-SITE BENCHMARK PRIOR TO USE.

CERTIFICATE OF SURVEYOR
I, TIMOTHY J. FOX, DO HEREBY STATE THAT I AM A REGISTERED LAND SURVEYOR, LICENSED BY THE STATE OF IDAHO, AND THIS TOPOGRAPHIC MAP HAS BEEN PREPARED FROM AN ACTUAL SURVEY MADE ON THE GROUND (05-10-12 through 05-14-12) UNDER MY DIRECT SUPERVISION AND IS AN ACCURATE REPRESENTATION OF SAID SURVEY.

CERTIFICATE NOTE
CERTIFICATION AND CERTIFY AS USED HEREIN MEAN TO STATE OR DECLARE A PROFESSIONAL OPINION OF CONDITIONS REGARDING THOSE FACTS OR FINDINGS, WHICH ARE THE SUBJECT OF THE CERTIFICATION, AND DOES NOT CONSTITUTE A WARRANTY OR GUARANTEE, EITHER EXPRESS OR IMPLIED.

TOPOGRAPHIC SURVEY FOR CSHQA (BUILDING 67 on the VA CAMPUS)			
A PORTION OF SOUTH WEST 14 OF SECTION 2 RANGE 3 NORTH 2 EAST BOISE MERIDIAN, CITY OF BOISE, ADA COUNTY, IDAHO			
FOX LAND SURVEYS, INC. 1515 SOUTH SHOSHONE STREET BOISE ID 83705 208-342-7957 - FAX 208-342-7437			
ACAD DWG. FILE	1222-01T	DR. KRA	CK. TJF
SCALE: 1"= 5'	DATE: MAY, 2012	SHEET 1 OF 1	

CSHQA 250 S. 5TH ST. BOISE, ID 83702 (208) 343-4635 FAX (208) 343-1858 http://www.cshqa.com	C.W. MOORE PLAZA 290 S. 5TH ST BOISE, IDAHO PHONE: 208-343-4635 FAX: 208-343-1858	THESE DRAWINGS AND SPECIFICATIONS, AS INSTRUMENTS OF SERVICE, ARE AND SHALL REMAIN THE PROPERTY OF THE ARCHITECT. ENGINEER WHETHER THE PROJECT FOR WHICH THEY ARE MADE IS EXECUTED OR NOT. THESE DRAWINGS AND SPECIFICATIONS SHALL NOT BE USED BY ANY PERSON OR ENTITY ON OTHER PROJECTS, FOR ADDITIONS TO THIS PROJECT, OR FOR ANY OTHER PROJECT, WITHOUT THE WRITTEN CONSENT OF CSHQA OR ITS AFFILIATES. Copyright 2013	STAMP	CAD FILE NAME: 531-320_G1.6.DWG XREF FILE NAME: 531-320_30X42TLBK.DWG	DRAWING TITLE SURVEY BY FLSI	PROJECT TITLE BOISE VAMC BUILDING 67 EXPANSION	DATE 07/12/2013	
					APPROVED: CHIEF OF FACILITY MANAGEMENT SERVICE	BUILDING NUMBER 67	CHECKED JDM	
REVISIONS		DATE		LOCATION VAMC BOISE, IDAHO		DWT 07 OF 191		DEPARTMENT OF VETERANS AFFAIRS